1 PROVIDE L3x3x3/16 H-FRAME AROUND ROOF DRAIN. COORDINATE SIZE AND LOCATION. WELD TO SUPPORTING MEMBERS WITH 3" OF 3/16" FILLET WELD EACH END.

(2) HORIZONTAL BRIDGING SHOWN FOR REFERENCE ONLY. JOIST MFR. SHALL LOCATE ALL REQUIRED BRIDGING.

PRE-ENGINEERED WOOD TRUSS PROFILE "A" @ SPACING SHOWN. REFER TO DETAIL

4 PRE-ENGINEERED WOOD TRUSS PROFILE "B" @ SPACING SHOWN. REFER TO DETAIL

5 PRE-ENGINEERED GIRDER TRUSS. TOP AND BOTTOM CHORD DIMENSION TO MATCH ADJOINING TRUSSES.

6 2x4 BLOCKING @ FLOOR OPENING.

7 HSS 4x4x3/8 STUB COLUMN W/ 3/4" THICK TYPE B BASEPLATE, L=9", W=10", SEE ?/S4.1.

(8) PRECAST MANUF. TO PROVIDE EMBED PLATE TO SUPPORT GIRDER TRUSS CONNECTION SIMILAR TO 1/S4.2. UNFACTORED DESIGN REACTION: 1.0 KIPS DL 0.95 KIPS LL

9 4x12 HEAVY TIMBER BEAMS @ SPACING INDICATED

10 PRECAST MANUF. TO PROVIDE EMBED PLATE FOR HIGH & LOW HSS ATTACHMENT. UNFACTORED DESIGN REACTION: P: 0.8 KIPS DL 0.6 KIPS LL

0.0 KIPS WL N: 0.0 KIPS DL

0.0 KIPS LL ± 3.4 KIPS WL

WOOD STUD FRAMED WALL, REFER TO ARCH.

12 PRE ENGINEERED WOOD TRUSS PROFILE "C" @ SPACING SHOWN. REFER TO DETAIL 2/S3.1.

(3) HATCHED AREA REPRESENTS WOOD FRAMED DECK & STAIR ON PONY WALL STRUCTURE. FRAME PONY WALLS PERPENDICULAR TO ROOF TRUSSES. SEE ARCH. FOR ADDITIONAL

PRE-ENGINEERED GIRDER TRUSS TO ATTACH TO PRE CAST WALL SIMILAR TO 7/S4.2. PRE CAST MANUF. TO PROVIDE EMBED PLATES FOR SEAT AND STABILIZER PLATE ATTACHMENTS UNFACTORED BOTTOM CHORD DESIGN REACTION: P: 4.8 KIPS DL 5.5 KIPS LL -1.7 KIPS WL (NET)


STICK FRAME SPANDRAL WALL BETWEEN SUPPORTS. ATTACH FRAMING AT EACH END W/ SIMSON LU HANGERS & 1" TEK SCREWS AS REQUIRED.

(3) 2 x 10 HEADER BEAM W/ (2) 1/2" PLYWOOD SPACERS AT OPENING, PROVIDE CRIPPLE STUD @ EACH END. (3) 1-3/4"x11-1/4" MICROLLAM LVL HEADER


BEAM AT OPENING, PROVIDE DOUBLE TRIMMER STUD AT EACH END FOR FULL


(18) HATCHED AREA REPRESENTS 3/4" PLYWOOD ROOF SHEATHING, REFER TO GENERAL NOTES FOR ADDITIONAL INFO.


PROVIDE SIMPSON CC0Q3-SDS2.5 OR EQUIVALENT COLUMN CAP FOR GIRDER TRUSS BEARING. WELD COLUMN CAP TO COLUMN ALL AROUND.

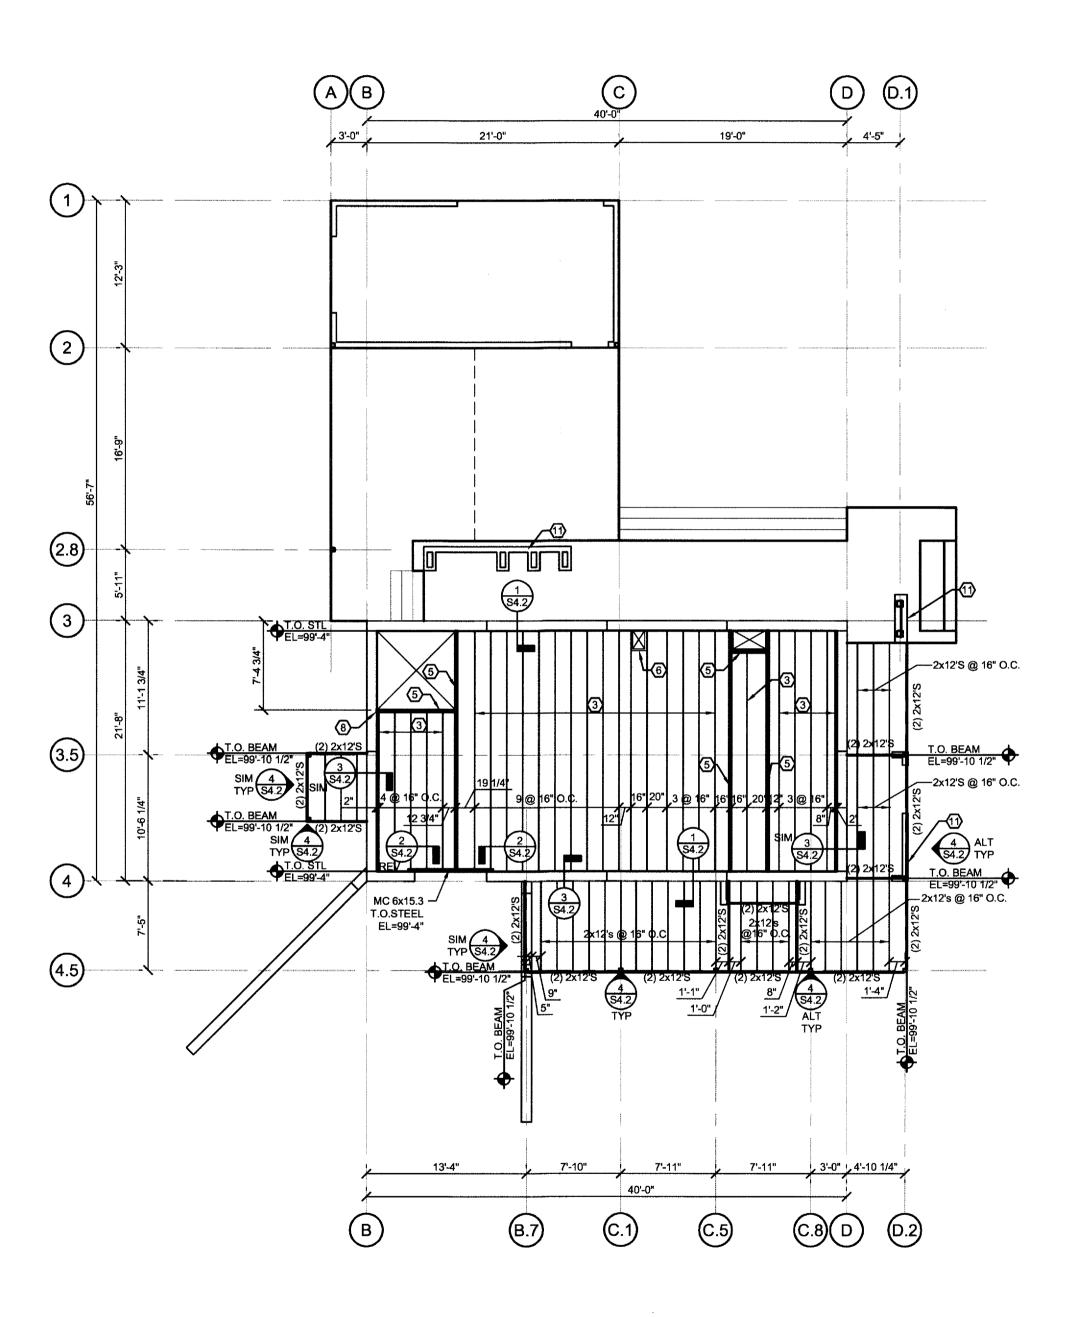


FIRST FLOOR FRAMING PLAN

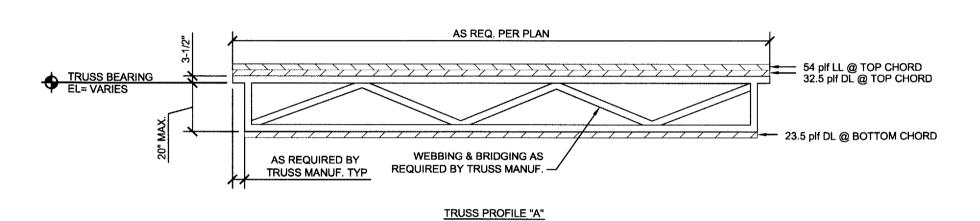

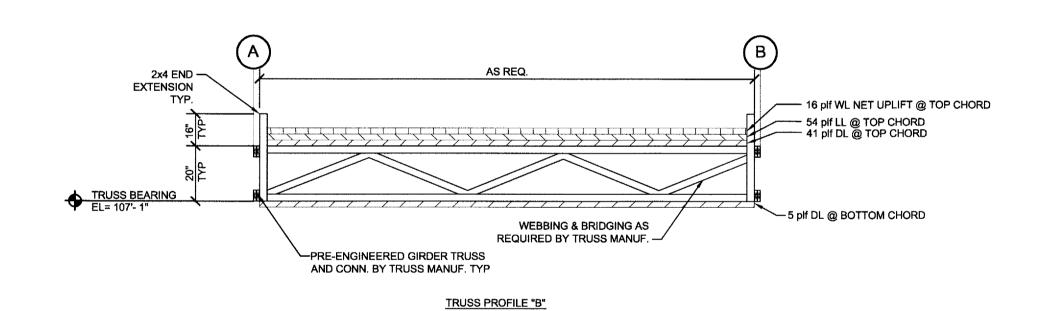

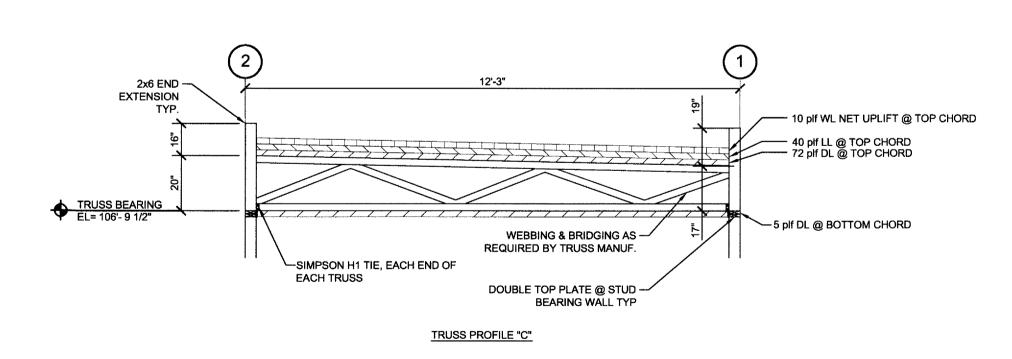


2 PRE ENGINEERED WOOD TRUSS PROFILES
SCALE: NOT TO SCALE

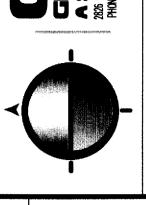

WEST BOIS

SIDENCE

Copyright © 2011 by

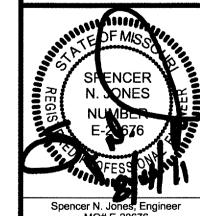

MO# E-28676 CHECKED BY: JCO DRAWN BY: JS JOB NUMBER: 10-2860 SCALE: SEE SHEET

> FIRST FLOOR FRAMING PLAN

ISSUE DATE: 08.04.2011